


ROOM INFORMATION CHART					
RM.NO.	RM.SQ. FOOTAGE	RM.NO.	RM.SQ. FOOTAGE	RM.NO.	RM.SQ. FOOTAGE
157	42	171	118	185	177
158	22	172	118	186	322
159	2219	173	142	187	118
160	187	174	3102	188	140
161	187	175	497	189	140
162	284	176	35	190	118
163	142	177	145	191	163
164	142	178	77	192	160
165	142	179	67	193	188
166	142	180	153	194	123
167	118	181	48	195	1303
168	142	182	401	196	834
169	118	183	1412	197	45
170	2755	184	89	198	207
				1-SIW-3	229
				1-ELEV-1	73
				UTILITY	60


GROSS MEASURED AREA (This sheet) = 17245
GROSS BUILDING AREA (This sheet) = 17717
TOTAL GROSS MEASURED AREA = 57910
TOTAL GROSS BUILDING AREA = 59284

NOTES

1. WALL THICKNESS IS 5" UNLESS OTHERWISE NOTED
2. GROSS MEASURED AREA SHALL MEAN THE TOTAL AREA OF A BUILDING ENCLOSED BY THE DOMINANT PORTION, EXCLUDING PARKING AREAS AND LOADING DOCKS (OR PORTION OF SAME) OUTSIDE THE BUILDING. CALCULATED BY A FLOOR BY FLOOR BASIS.
3. GROSS BUILDING AREA SHALL MEAN THE TOTAL CONSTRUCTED AREA OF A BUILDING.
4. THIS IS A SAMPLE STRUCTURE FOR DEMONSTRATION PURPOSES ONLY.
5. ANSI/BOMA Z65.1-0996 STANDARD METHOD USED FOR MEASURING FLOOR AREA IN BUILDINGS.

"PRIORITY DRAWING"

NO	DATE	CLASS REV	DESCRIPTION	DWN	VER	CHKD	SUB	APP
								
LEM EXAMPLE DRAWING ARCHITECTURAL								
FLOOR PLAN OF RECORD								
BLDG SUBMITTED								
TA- APPROVED FOR RELEASE								
SHEET A-1000								
Los Alamos NATIONAL LABORATORY								
PO Box 1663 Los Alamos, New Mexico 87545								
CLASSIFICATION U								
PROJECT ID								
DRAWING NO								
DATE								
REV 0								

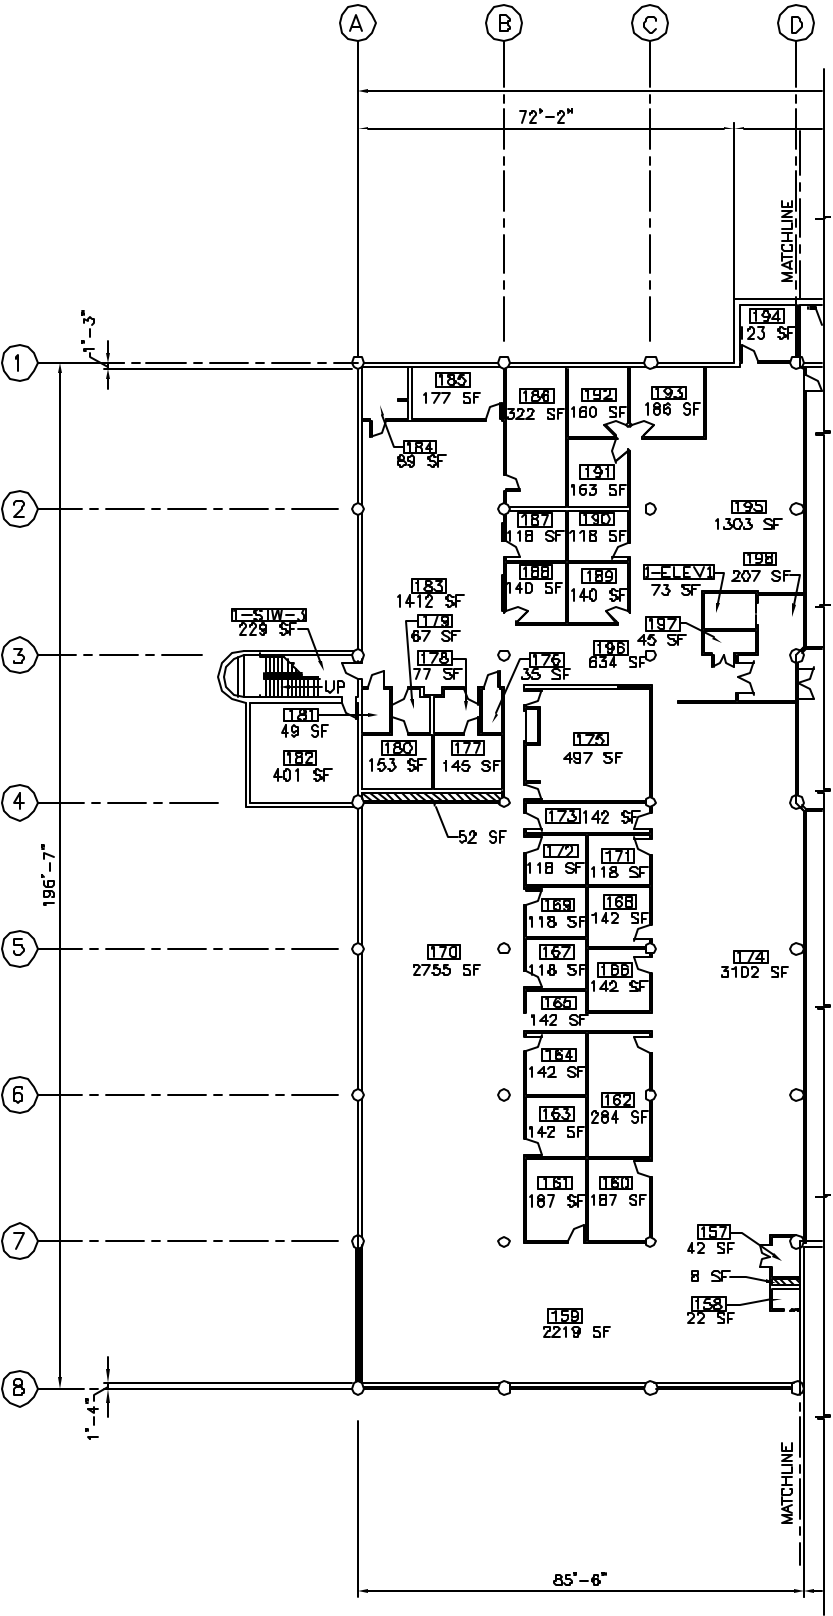

PARTIAL FIRST FLOOR PLAN - SOUTH
SCALE: 1/16"=1'-0"
1/16" = 1'-0"